

MAGNETIC

BENCHMARK-TOP
OF SPIKE 70.50'

EDGE OF NEW 14'
WIDE ROAD

EXISTING EDGE OF
GRAVEL

LOCATION OF BYPASS
PUMPING DAM AND
CHANNEL

ROGERS BROOK


ROGERS ROAD

NEW 14' x 8' 11"
MULTI-ARCH
CULVERT SET 3' BELOW
EXISTING STREAMBED

EXISTING 48" CULVERT
TO BE REMOVED

APPROX ROW

GRAPHIC SCALE

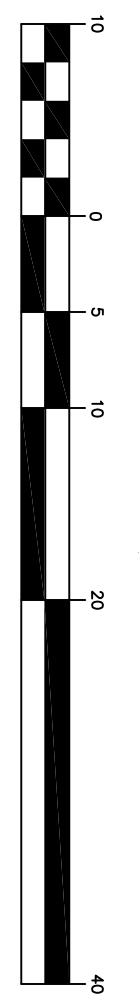

SHEET NO. 2	<input type="checkbox"/> RECORD DRAWING	<input type="checkbox"/> INSTRUMENTAL	DATE 12/15/19
DESIGNER O'LEARY-BURKE	<input checked="" type="checkbox"/> FINAL	<input type="checkbox"/> PRE-APPLICATION	PROJECT NO. 200-019-98
DRAWN BY BWC			SCALE 1"=10'
CHECKED BY PJO			
SCALE 1"=10'			
O'LEARY-BURKE CIVIL ASSOCIATES, P.C. 17 COOPERATIVE DR. WESTFORD, VT 05151 PHONE: 802-888-8888 FAX: 802-888-8889 EMAIL: OLEARY@OLEARY-PC.COM			ROGERS ROAD CULVERT REPLACEMENT WESTFORD, VT SITE PLAN PLAN SHEET # 2